


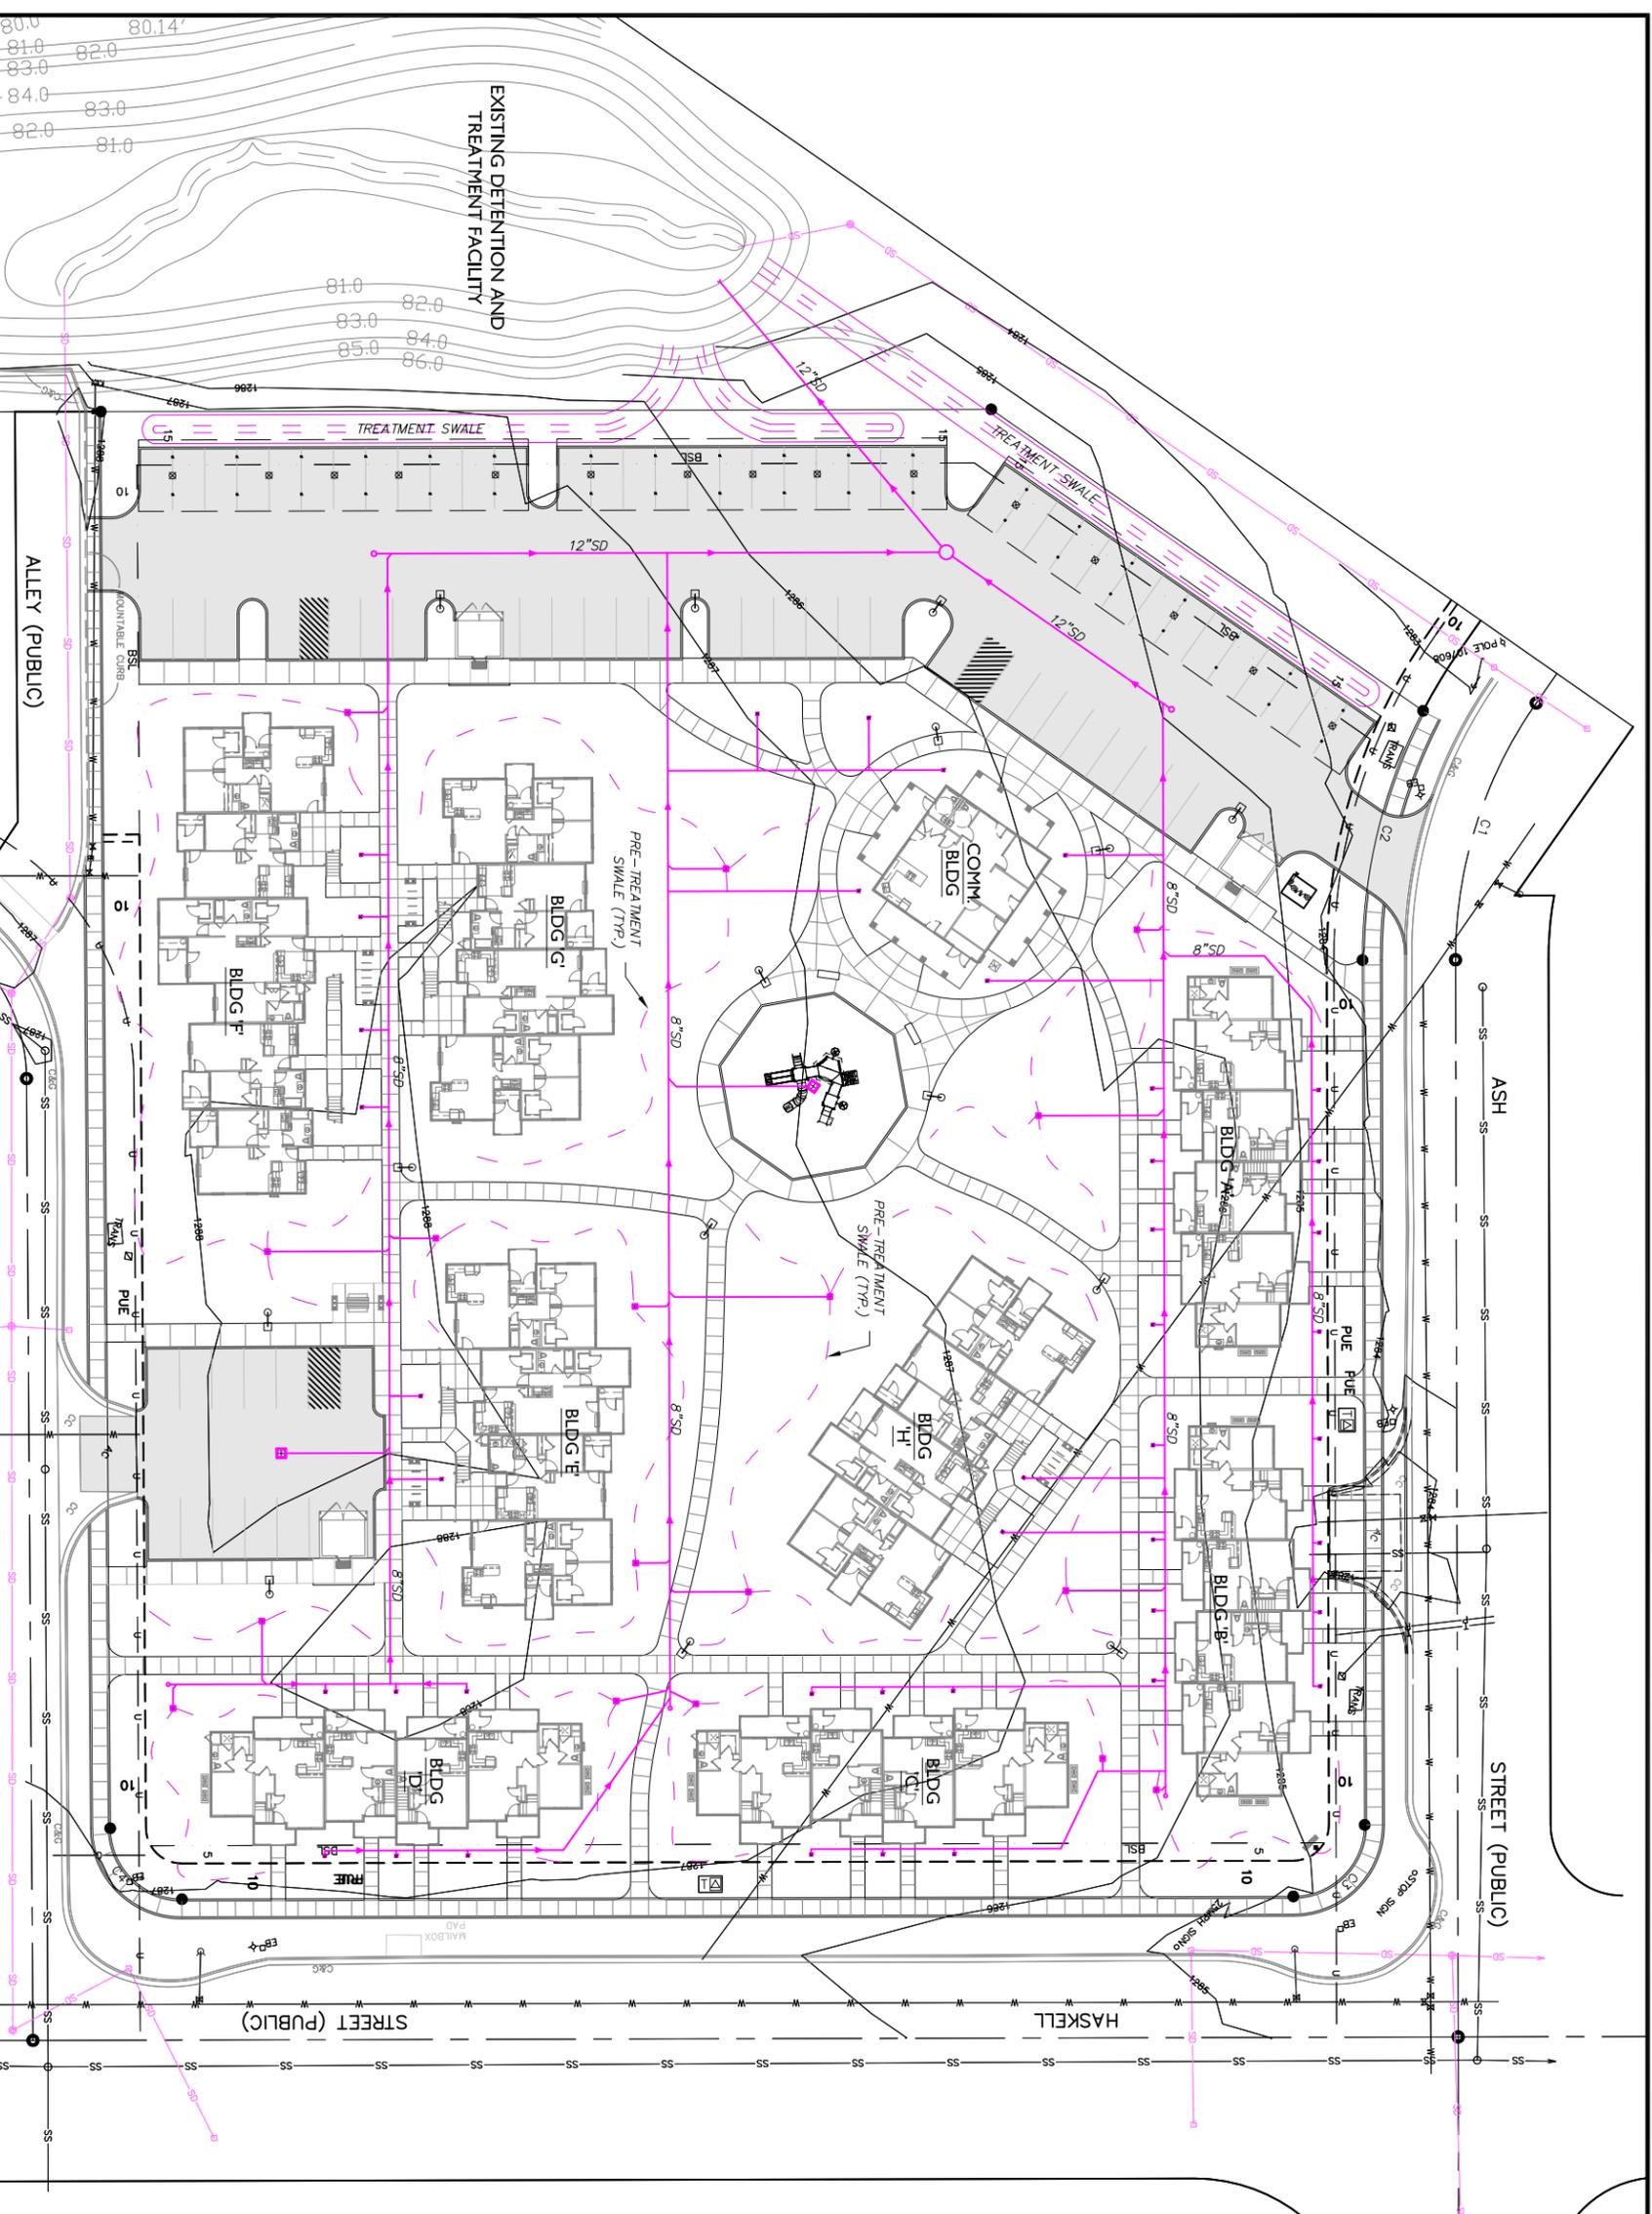

SCALE: 1"=50'  
(11X17)

- EXISTING STORM DRAIN
- EXISTING STORM DRAIN INLET
- PROPOSED SD MANHOLE
- PROPOSED SD CURB INLET
- PROPOSED SD CATCH BASIN
- ◆ PROPOSED SD FACILITY OUTLET CONTROL STRUCTURE
- XX"SD PROPOSED STORM DRAIN LINE



CALL 419-888 BEFORE YOU DIG

**CONSTRUCTION ENGINEERING CONSULTANTS, INC.**

P.O. BOX 1724 • MERFORD, OREGON 97501  
PH. (541) 779-5288 • FAX (541) 779-3139

NO.	REVISION	DATE	BY

DRAWN BY: BSH	DATE: 01/17
CHECKED BY: AMB	DATE: 01/17
APPROVED R/S:	DATE:
APPROVED:	DATE:
APPROVED:	DATE:

NOT FOR CONSTRUCTION

CREEKSIDE STORMWATER MANAGEMENT PRELIMINARY SITE PLAN

REV. CITY ENGINEER: \_\_\_\_\_ DATE: \_\_\_\_\_

NAME: A.Z. SITE PLANNING PROJ: 16-75 PLOT DATE: 01/10/17